

JON M. HUNTSMAN, JR. Governor

GARY R. HERBERT Lieutenant Governor

Department of Administrative Services

KIMBERLY HOOD Executive Director

Division of Facilities Construction and Management

Director

ADDENDUM #1

Date: 6 February 2007

To: Contractors

From: Bob Anderson, Project Manager, DFCM

Reference: Stores & Receiving Building Expansion/Remodel Phase 2

Weber State University

DFCM Project #: 05276810

Addendum No. 1 Subject:

Pages: Addendum 3 pages

> Architectural Addendum 8 pages **Total Pages** 11 pages

Note: This Addendum shall be included as part of the Contract Documents. Items in this Addendum apply to all drawings and specification sections whether referenced or not involving the portion of the work added, deleted, modified, or otherwise addressed in the Addendum. Acknowledge receipt of this Addendum in the space provided on the Bid Form. Failure to do so may subject the Bidder to disqualification.

1.1 SCHEDULE CHANGES: There are no schedule changes per this Addendum.

1.2 GENERAL

Reference the attached general items and architectural drawings.

End of Addendum #1





Addendum No. 01

Project: Stores & Receiving Building Expansion / Remodel Phase 2

05 February 2007

Address: Weber State University

Project No.: 0528.01.02

City, State: Ogden, Utah

05276810

Owner: DFCM

Agency:

Owner No.:

Date:

Weber State University

To all Bidders of Record:

This addendum forms a part of the contract documents and modifies the original specifications and drawings as noted below. Items of general information are included without reference to the plans and specifications. Revisions to the specifications are referenced by page number and paragraph heading on that page. Revisions to the drawings are reference by the drawing number. Unless otherwise stated, any changes herein offset only the specific drawings, words, or paragraphs mentioned, and the balance of the drawings and specifications remain in full force. Acknowledge receipt of this addendum in the space provided on the Bid form. Failure to do so will subject the Bidder to disqualification.

ARCHITECTURAL ADDENDUM

Item Section or No. Sheet No.

Description

General Items:


- 1-1 Questions
- !. Missing room finish schedules?
 - A. There are no 'room finish schedules', see floor plan (AE101) for room name/finish designation and sheet AE101 for Finish Legend.
- 2. Is there going to be details for the new penetrations going through the existing CMU wall?
 - A. No, there is a bond beam at 8'-0". Since we are penetrating just below this no additional support will be needed.
- 3. Will there be details of the support structure for the new rooftop units?
 - A. The details are attached to this addendum.
- 4. On the exterior elevation the 2 new windows are called out to be aluminum, the details show hollow metal frames, which is it?
 - A. The details are correct, the windows are hollow metal.
- 5. The specs for the carpet do not call out a style, color or manufacture.
 - A. It is Mohawk carpet, the pattern is Spring Break, and the color is 8929 Playtime.
- 6. What is the height of the walls?
 - A. 9'-8" to the underside of the second floor deck.

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Specification 1 -2	ns Items: 06402-6	 Sect. 2.5: Add the following: D. AWI type of countertop construction: Flush overlay. 1. High pressure decorative laminate 0.0500 " thick with integral backsplash and radiused front edge.
1 -3	06402-9	 Sect 3.5, Para C: Add the following: Accuride, side-mounted, full-extension, zinc-plated steel drawer slides with steel ball bearings, complying with BHMA A156.9, Grade 1 and rated for the following loads: 1. Cabinet Drawer Slides: Accuride full extension progressive drawer guide, 150 lb. 417-4005.
1 -4	09255	Add resilient channel and sound batts to this section for the sound walls called out on the floor plan AE101. Add ½" Dens Deck for exterior sheathing at E.I.F.S infill on west elevation A2/AE401.
Drawing Items:		
1 -5	AE101	Floor Plan: Saw cut concrete slab to accommodate new drain line from sink. Saw cut from location to new sink 12'-0" to the west along the existing masonry wall.
1 -6	AE101	Floor Plan: Add note to southwest corner of Copy Center 101, "EXISTING LEAK TO BE REPAIRED – ASSUME LEAK FOLLOWS CONDUIT BEGINNING AT 4'-0" A.F.F. TO ROOF DECK ABOVE – TRACE PATH & SEAL INFILTRATION AREA".
1 -7	MH102	Locate rooftop unit RTU-1 west of the wall between the warehouse and Printing Services. Provide a side discharge roof curb similar to section A/MH102. Extend the supply and return air ductwork above the roof to the roof penetration locations shown. Coordinate the exact location of the unit with the Architect and Structural Engineer.
1 -8	Details	Add the attached details: Roof Ladder Detail, Roof Hatch Detail, Mechanical Curb Detail, EIFS Infill/Window Detail, Structural Detail S1, Structural Detail S2, Structural Detail S3, Structural Detail S4.
Drior Approvale		
Prior Approvals: 1 -9		None this addendum.

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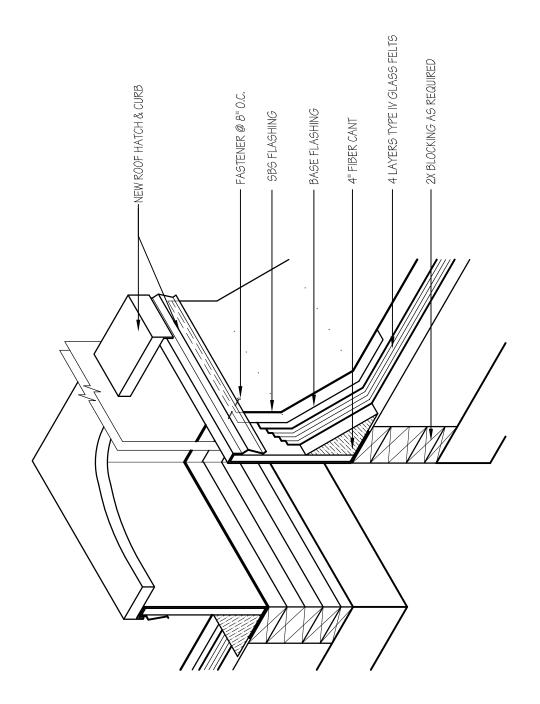
ROOF LADDER DETAIL Stores & Receiving Expansion/Remodel

CLIENT PROJ No 05276810 HFSA PROJ NO 0528.01.02 DATE: 05 FEB 2007

1/2"=1'-0"

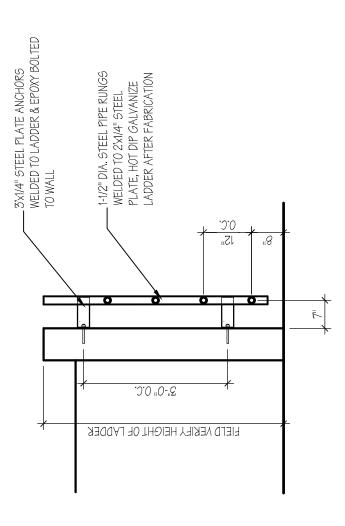SCALE


1484 S. State Street Salt Lake City, UT 84115 Tel: 801-596-0691 Fax: 596-0693 www.hfsa.com



Stores & Receiving Expansion/Remodel

DATE: 05 FEB 2007 CLIENT PROJ NO 05276810 HFSA PROJ NO 0528.01.02

SCALE: 1-1/2"=1'-0"

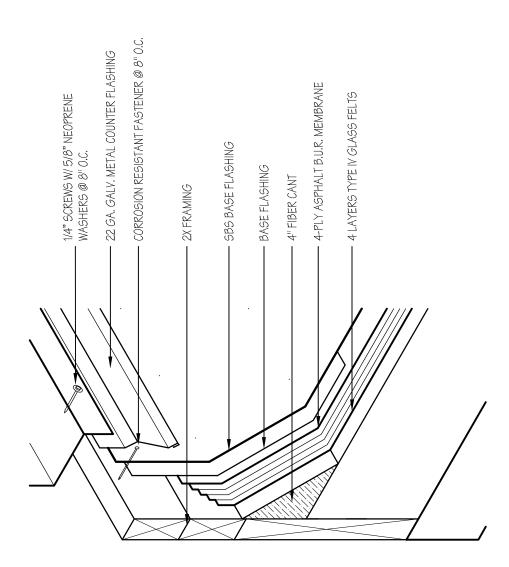

HFSArchitects Architecture Interiors PLANNING


MECHANICAL CURB DETAIL Stores & Receiving Expansion/Remodel

05 FEB 2007

2"=1'-0"

SCALE:


CLIENT PROJ No 05276810 HFSA PROJ NO 0528.01.02

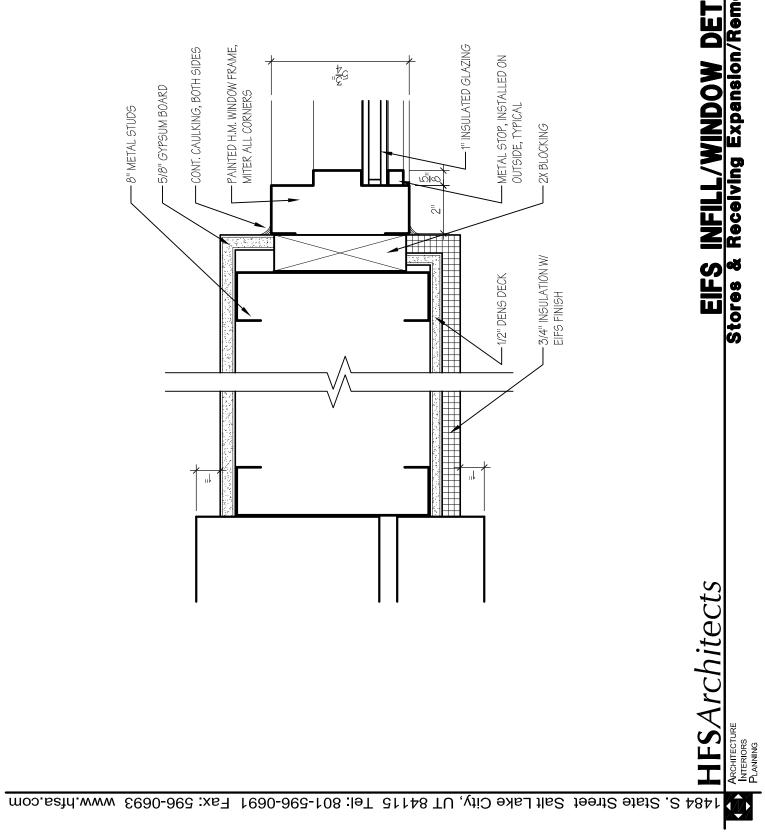

EIFS INFILL/WINDOW DETAIL Stores & Receiving Expansion/Remodel

3"=1'-0"

SCALE

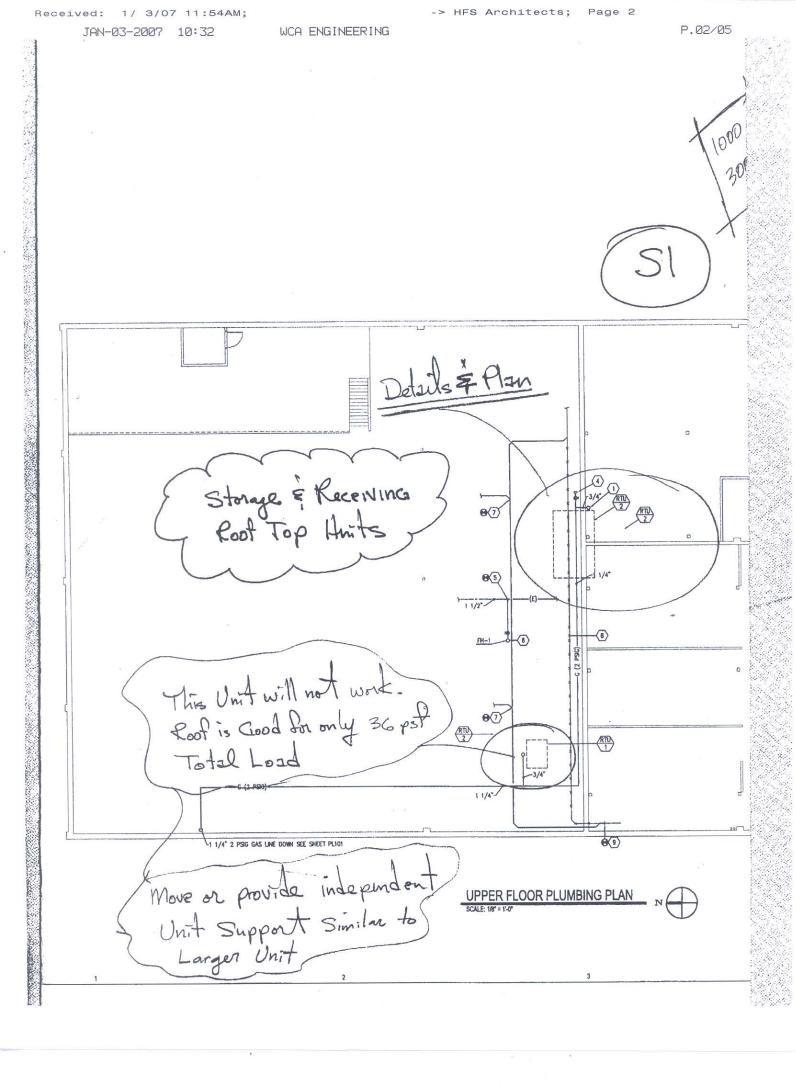

-> HFS Architects; Page 3

JAN-03-2007 10:33

WCA ENGINEERING

P.03/05

Structural
Engineering inc.

442 NORTH MAIN STREET, BOUNTIFUL, UTAH 84010
801-298-1118 OFFICE 801-298-1122 FAX
wca@aros.net

PROJECT:

PROJECT:


PROJECT:

TOPIC:

TOPIC:

TOPIC:

Frame for Rept land
ENGINEER:

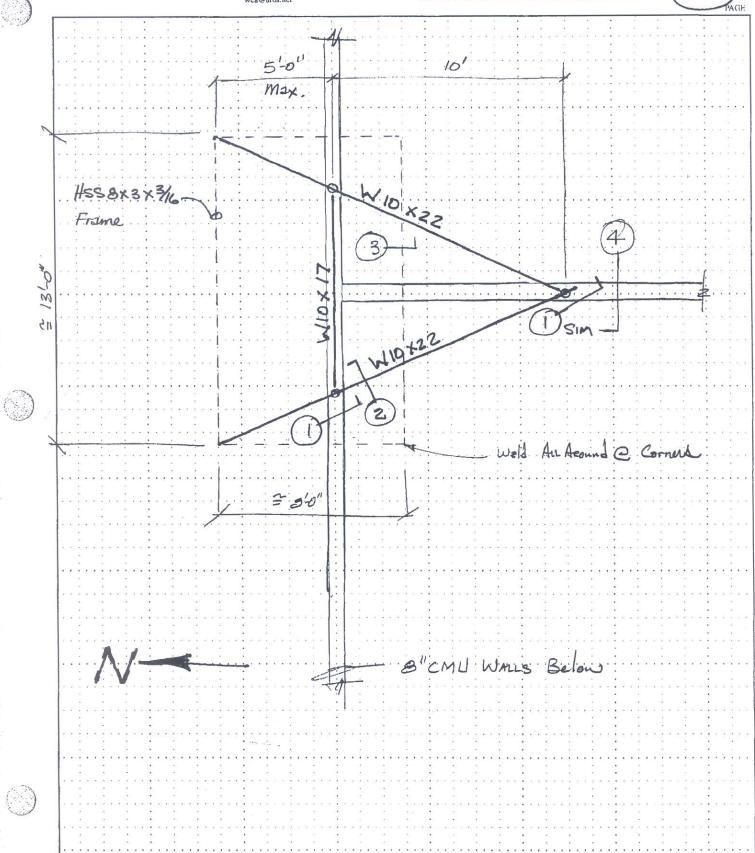

JAN-03-2007 10:33 WCA ENGINEERING


P.04/05



Structural

142 NORTH MAIN STREET, BOUNTIFUL, UTAH 84010 801-298-1118 OFFICE 801-298-1122 FAX

PROJECT PROJECT# CLIENT

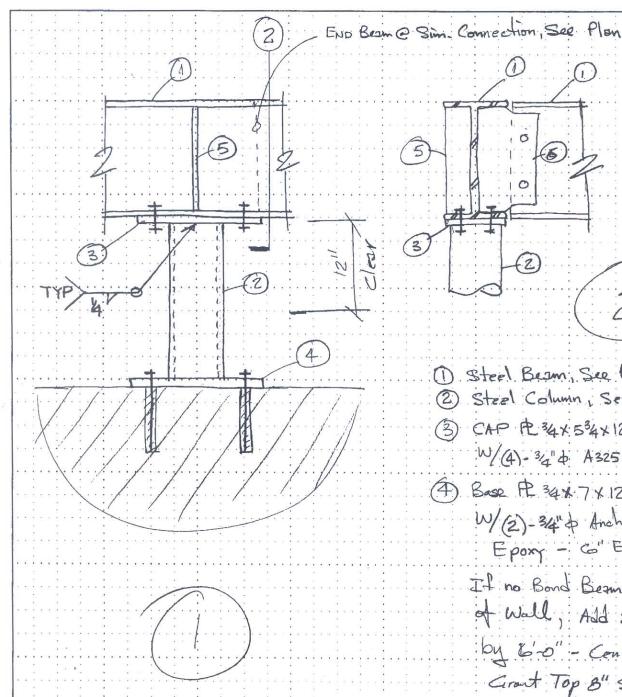

(1) Steel Beam, See Plan

Steel Column, See Plan

(3) CAP P. 34×534×12* W/4)-3/4" & A325 Botts

(4) Base P 34x7x12 * W/(2)-34" & Anchor Bolts

> It no Bond Beam @ Top of Wall, Add 2# 5 Hors. by 600 - Center & Grant Top 8" Solid.

* Run Ps 11 to Beam & Wall

5 5/6" Stiffener A

(6) 5/6 Stillmer - Shear A W/(2)-34" & A325 Bolls

1/ 3/07 11:55AM; 10:34 JAN-03-2007

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P.05/05

TOTAL P.05

Structural Engineering inc.

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CLIENT

